


TO THE BEST OF THE ENGINEER'S KNOWLEDGE,
THE PLANS AND SPECIFICATIONS COMPLY WITH
THE APPLICABLE MINIMUM BUILDING CODES AND
STANDARDS.

BLDG 03 - FOUNDATION & SLAB PLAN

1/8" = 1'-0"

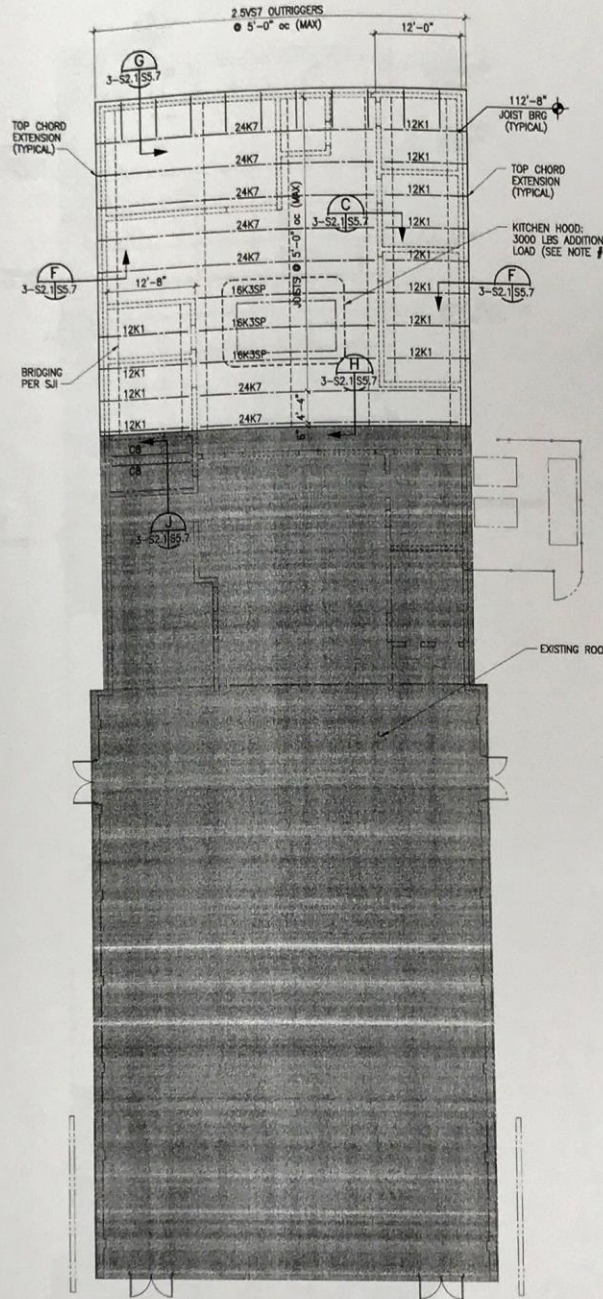

TO THE BEST OF THE ENGINEER'S KNOWLEDGE,
THE PLANS AND SPECIFICATIONS COMPLY WITH
THE APPLICABLE MINIMUM BUILDING CODES AND
STANDARDS.

BLDG 03 - ROOF FRAMING PLAN

1/8" = 1'-0"



GROUND FLOOR NOTES & ABBREVIATIONS

- 1). SEE DWG S1.1 FOR GENERAL NOTES AND LEGEND.
 - 2). COORDINATE ALL WALL DIMENSIONS AND OPENINGS WITH ARCHITECTURAL DRAWINGS.
 - 3). SEE ARCHITECTURAL DRAWINGS FOR GROUND FLOOR EXTERIOR CONCRETE SLAB LAYOUT, SLOPES, CONTROL JOINTS AND ELEVATIONS.
 - 4). PROVIDE THICKENED SLAB EDGE (TE) AT ALL DOOR OPENINGS TO THE EXTERIOR. SEE DWG SS.3 FOR DETAIL.
 - 5). TOP OF FOOTING ELEVATION = 98'-8" U.I.C.O.
 - 6). DROP WALL FOOTINGS (DF) AS NECESSARY FOR UNDERGROUND PIPING. SEE DWG SS.3 FOR DETAIL.
 - 7). PROVIDE #3 BAR x 3'-6" LG ABOVE SLAB REINFORCEMENT AT ALL RE-ENTRANT CORNERS IN SLAB ON GRADE (TYPICAL).
- (XX) INDICATES SCHEDULED SIZE
- CJ = CONTROL JOINT. SEE DWG SS.3 FOR DETAIL.
 - MCJ = MASONRY CONTROL JOINT. SEE DWG SS.2 FOR DETAIL.
 - WF(XX) = CONTINUOUS WALL FOOTING. SEE SCHEDULE ON DWG SS.1.
 - F(XX) = SPREAD FOOTING. SEE SCHEDULE ON DWG SS.1.
 - DF = DROPPED FOOTING. SEE DWG SS.3 FOR DETAIL.
 - MW(XX) = MASONRY WALL REINFORCING. SEE SCHEDULE ON DWG SS.1.
 - CC-(XX) = CONCRETE COLUMN. SEE SCHEDULE ON DWG SS.1.
 - SC-(XX) = STEEL COLUMN. SEE SCHEDULE ON DWG SS.1.
 - MC-(XX) = MASONRY COLUMN. SEE SCHEDULE ON DWG SS.1.
 - TE = THICKENED SLAB EDGE. SEE SCHEDULE ON DWG SS.1.
 - TS = THICKENED SLAB. SEE SCHEDULE ON DWG SS.1.
 - ▨ = INDICATES DEPRESSED SLAB. SEE DWG SS.4 FOR DETAIL.

ROOF FRAMING NOTES

- 1). SEE DWG S1.1 FOR GENERAL NOTES AND LEGEND.
 - 2). TOP OF JOIST ELEVATION VARIES. REFER TO ARCHITECTURAL DRAWINGS FOR SLOPE AND HIGH/LOW POINTS. JOIST BEARING NOTED ON PLAN THUS ↕
 - 3). ROOF DECK SHALL BE 1 1/2", 20 GAGE, GALVANIZED TYPE B ROOF DECK.
 - 4). SEE DWG 5-5.4 FOR TYPICAL ROOF OPENING SECTION.
 - 5). FOR LOCATION OF ADDITIONAL LOADS, COORDINATE W/ ARCHITECTURAL AND MECHANICAL DRAWINGS.
- (XX) INDICATES SCHEDULED SIZE
- BR-(XX) = CONCRETE ROOF BEAM. SEE SCHEDULE ON DWG SS.2
 - WP-(XX) = STEEL WALL CONNECTION PLATE. SEE SCHEDULE AND DETAIL ON DWG SS.2

ARCH/ENGR OF RECORD
ANDREW H. MILLER
FL. REG. 38181

DESIGNED BY
LUZNAK

DRAWN BY
ROLL

CHECKED BY

PROJECT NO./CAD NO.
5254.01\03-52

DATE
06-06-03

DRAWING NO.
03-52

KEY PLAN

UMATILLA HIGH SCHOOL
UMATILLA, FLORIDA
LAKE COUNTY SCHOOLS
BLDG 3 - FOUNDATION & ROOF PLANS

BRPH ARCHITECTS ENGINEERS, INC.
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Board of Professional Engineers No. 1438
Professional Seal of Andrew H. Miller, P.E. No. 38181

NO.	REVISION	DATE

